

1 Section 1 1/2" = 1'-0"

- 4" GRAVEL BED

General Notes:

All work to be in compliance with the current residential standards of the National Building Code of Canada, current electrical and plumbing codes and all local building code and bylaws which may take precedence.

All work shall be performed in all respects to good building practice.

Written dimensions to be followed. DO NOT scale from drawings.

All floor joists and beams to be SPF #2 or better or as noted.

Wood in contact with concrete to be damp-proofed with 45 lb. felt, 6 mil. poly or other approved method. Plates to be anchored to concrete with 1/2" dia. anchor bolts at maximum 6'0" O.C. and at all corners. All soils to be inspected by a geotechnical eng. to confirm load bearing capacity, the eng. shall inspect and approve the excavated hole before placing of concrete.

All measurements, grades and levels to be verified on site before commencing construction.

Perimeter drainage shall be installedwhere required by local authorities having jurisdiction and to their approval.

All concrete to have a minimum compressive strenght of 20 mpa at 28 days.

Floor joists spans of more than 7'0" shall be bridged at mid-span or at 7'0" O.C. maximum. Bridging shall be 2"x2"

diagonal type cross bridging installed as required by the N.B.C.

Flashing to be installed at all penetrations in roof systems and changes in roof plane.

All electrical/plumbing fixturing to be verified with owner.

Flashing to be installed at all changes in horizontal exterior finishings and over all unprotected openings.

Caulking to be installed around all unflashed exterior openings. Flashing to be installed at all changes in

horizontal exterior finishings and over all unprotected openings. Caulking to be installed around all unflashed exterior openings.

Moisture resistant drywall is required around bathtubs or showers where tile is installed. Main entry door to have sidelite or viewer.

PERRY KOLEBA/ARC DRAFTING & DESIGN shall not be responsible for any variances from the structural drawings and specifications, or adjustments required resulting from conditions encountered at the job site, and is the sole responsibility of the owner or contractor.

PERRY KOLEBA/ARC DRAFTING & DESIGN makes every effort to provide complete and accurate construction drawings. However, we assume no liability for any errors or omissions which may affect construction. It is the responsibility of all trades and sub-trades to check and verify all responsibility of all trades and sub-trades to check and verify all dimensions and details before commencing with their portion of the construction. Should any discrepancies be found on these plans please advise our office so we can make the necessary corrections.

INTERIOR SWING DOORS:

Rough opening is always 82 1/2" high x 2" greater than nominal door size.

EXAMPLE: 2/8 X 6/8 = 34"X 82 1/2"

INTERIOR BIFOLDS:

EXAMPLE: $5/0 \times 6/8 = 61$ " x 81 1/2"

Rough openings for 2 panel doors are
1 1/4" greater than nominal door width & 1 1/2" greater than door height.

EXAMPLE: 3/0 x 6/8 = 37 1/4"x81 1/2"

Rough openings for 4 panel doors are 1"

greater than nominal door width and 1 1/2" greater than height.

ROOF CONSTRUCTION

-2x6 T&G ROOF DECK, BLUE SKIN MEMBRANE, 22GA
METAL STANDING SEAM
(SLOPES UNDER 4/12 PEEL & STICK UNDERLAY)

-6X10 ROUGH SAWN FIR RAFTERS @ 4'-0"0.c

EXTERIOR WALL CONSTR

(HEEL CUT VARIES)

-STUCCO FINISH
-BUILDING WRAP
-3/8" SHEATHING
-R-24 INSULATION
-(2x6)@16"O.C. ALL FLRS
-6MIL POLY, 1/2" DRYWALL

INTERIOR WALL@MAIN FLR
- 1/2" GYPSUM BOARD TO BOTH
SIDES OF 2X4 SPRUCE STUDS@16 O.C.

<u>SLAB ON GRADE</u> - 5" CONC SLAB, 25MPA, 10M REBAR @16" O.C. - 6 MIL. POLY. VAPOUR BARRIER

INTERIOR FLOOR CONSTRUCTION
-FINISHED FLOORING

-FINISHED FLOORING
- 3/8" UNDERLAY (PREMIUM) @ TILE AREAS
- 5/8 T.&G. FIR SUB-FLOOR, ENG FLR SYSTEM, SPACING AS PER MANUFACTUER (GLUED& SCREMED)

NOTE: RE FOOTINGS & FOUNDATION ALSO REFER TO ENGINEERS DRAWINGS FOR ALL FOUNDATION WALLS OVER 8"-0" HIGH



Consultant
Address
Address
Phone
Fax
e-mail

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Address
Address
Phone
Fax
e-mail

Description	
	Description

Client: Harmati

Address:

Carmi, B.C.

Project:


Yoga Studio

Building Sections

Project number	01/Beaux/2023	
Date	Feb 13/2023	
Drawn by	Author	
Checked by	Checker	
A 0		

A3

Scale 1/2" = 1'-0"

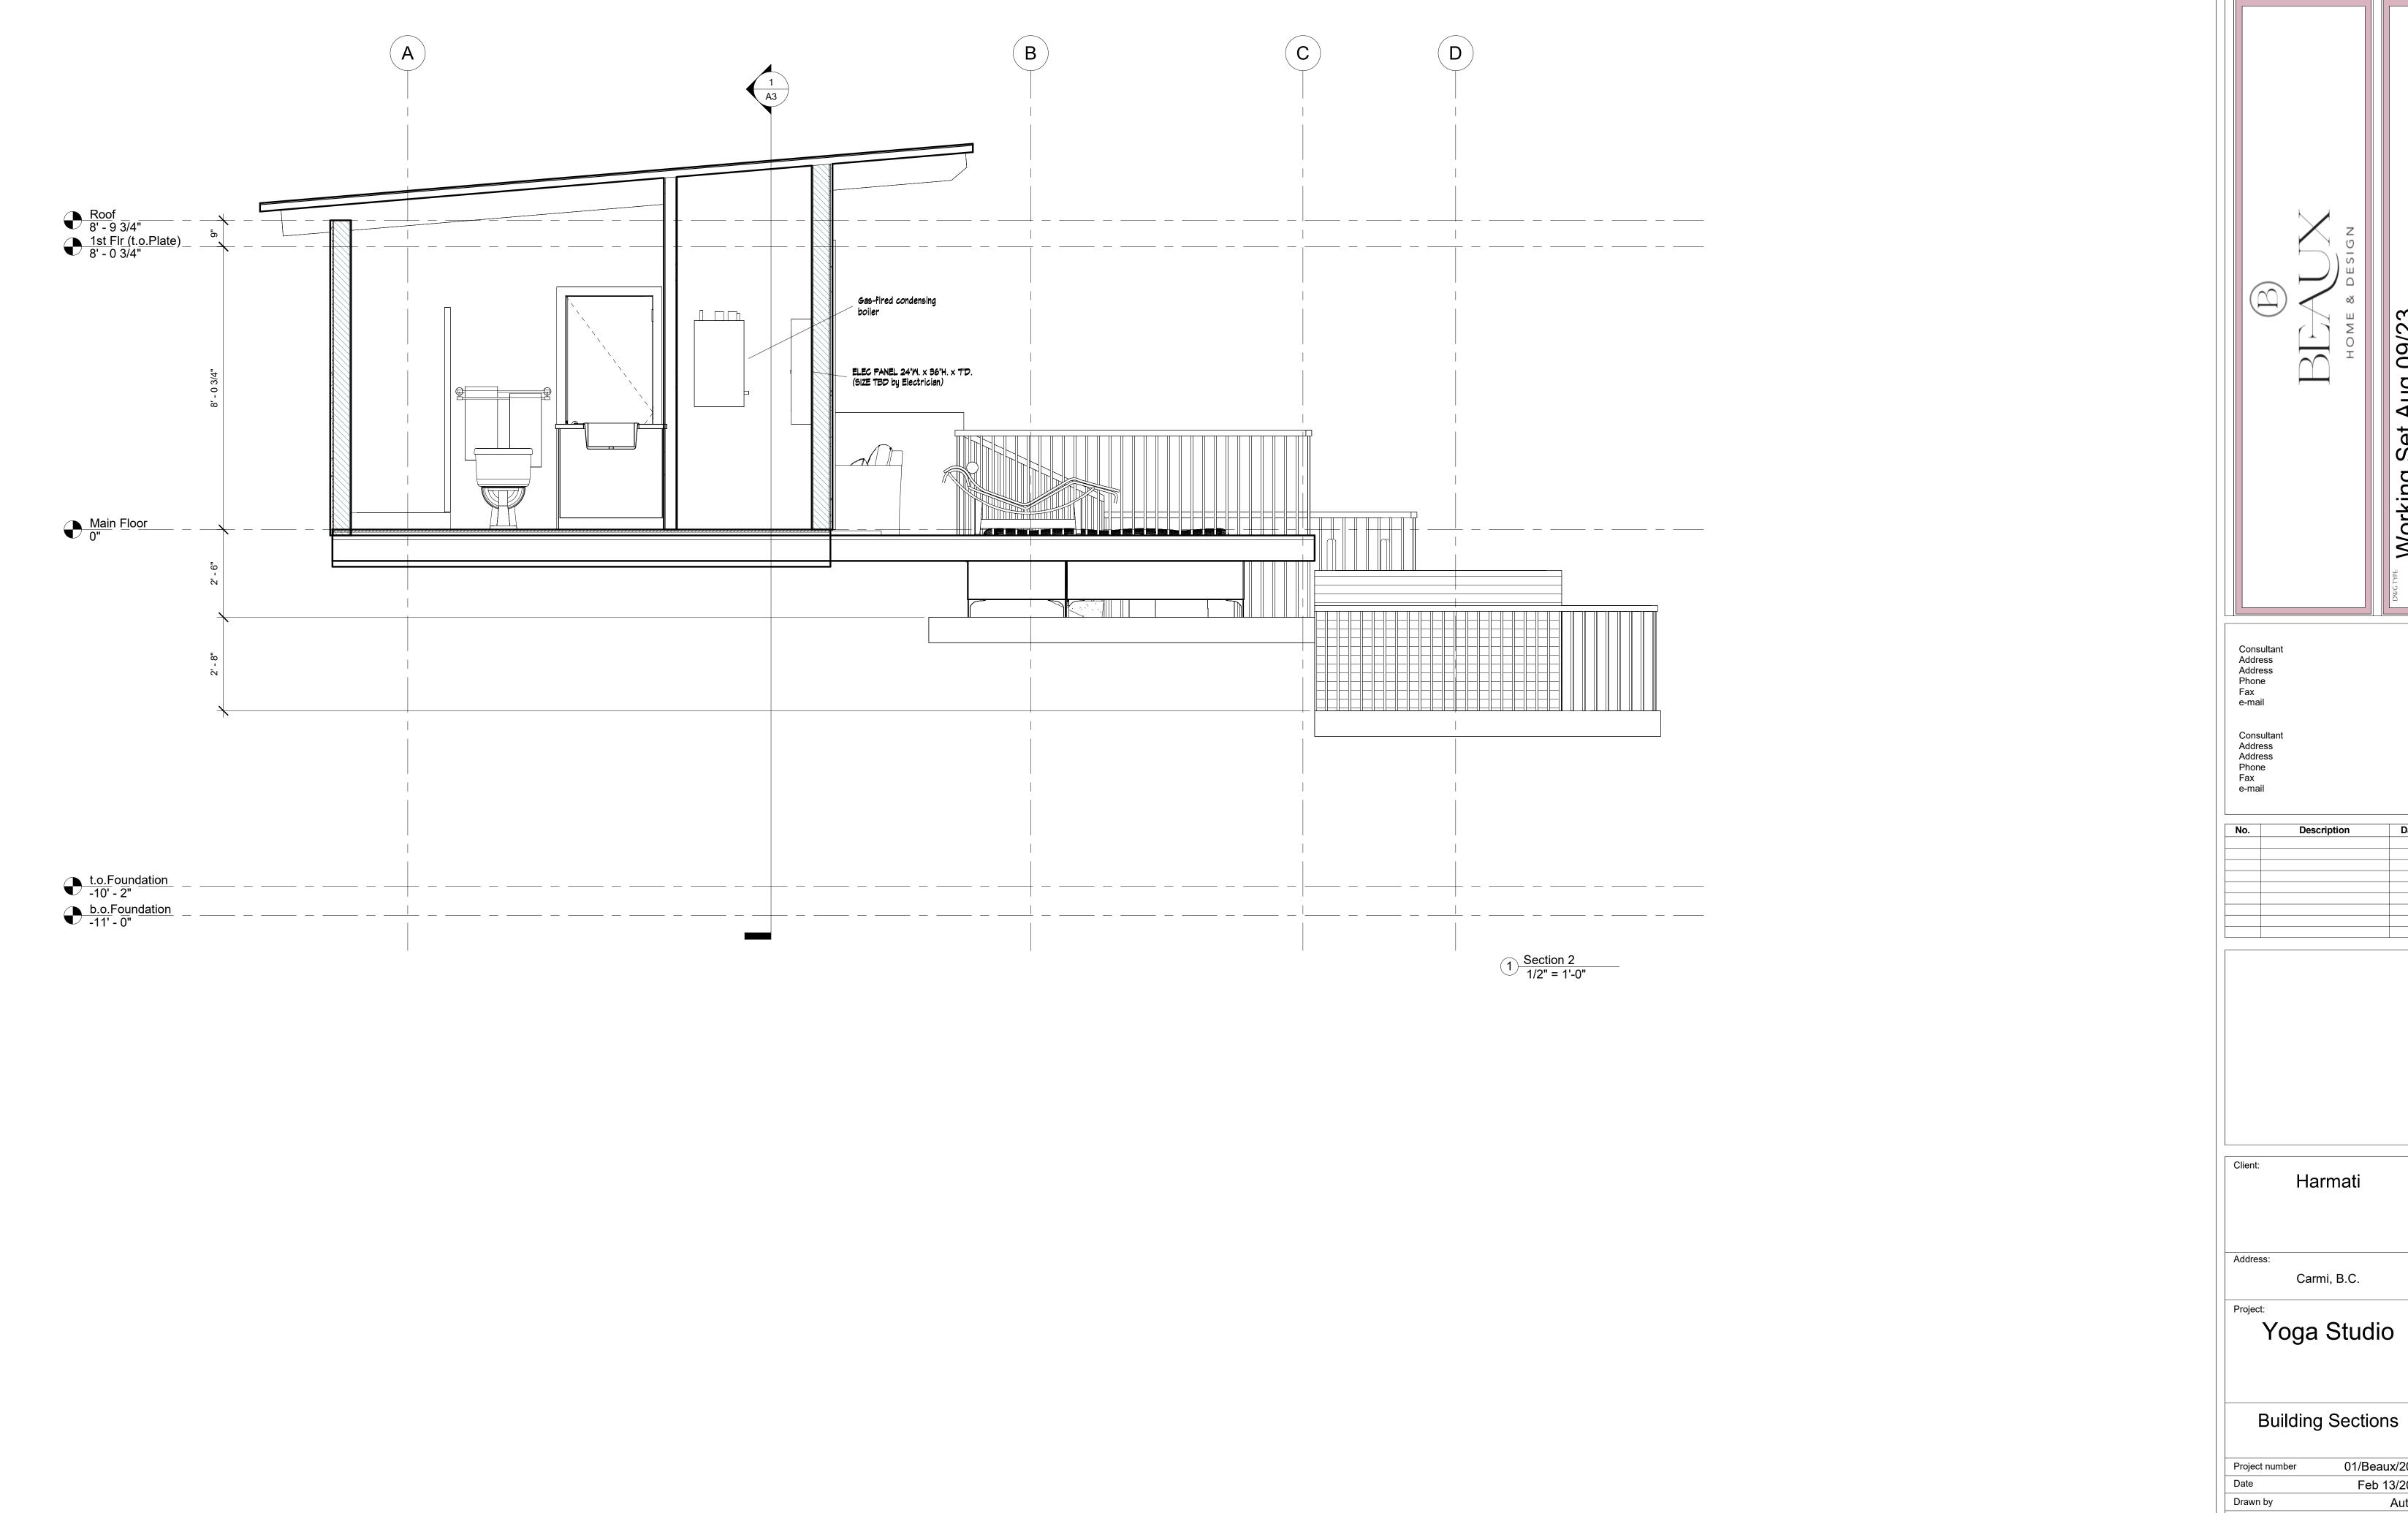



01/Beaux/2023 Feb 13/2023


Scale

Author Checker Checked by A4

1/2" = 1'-0"

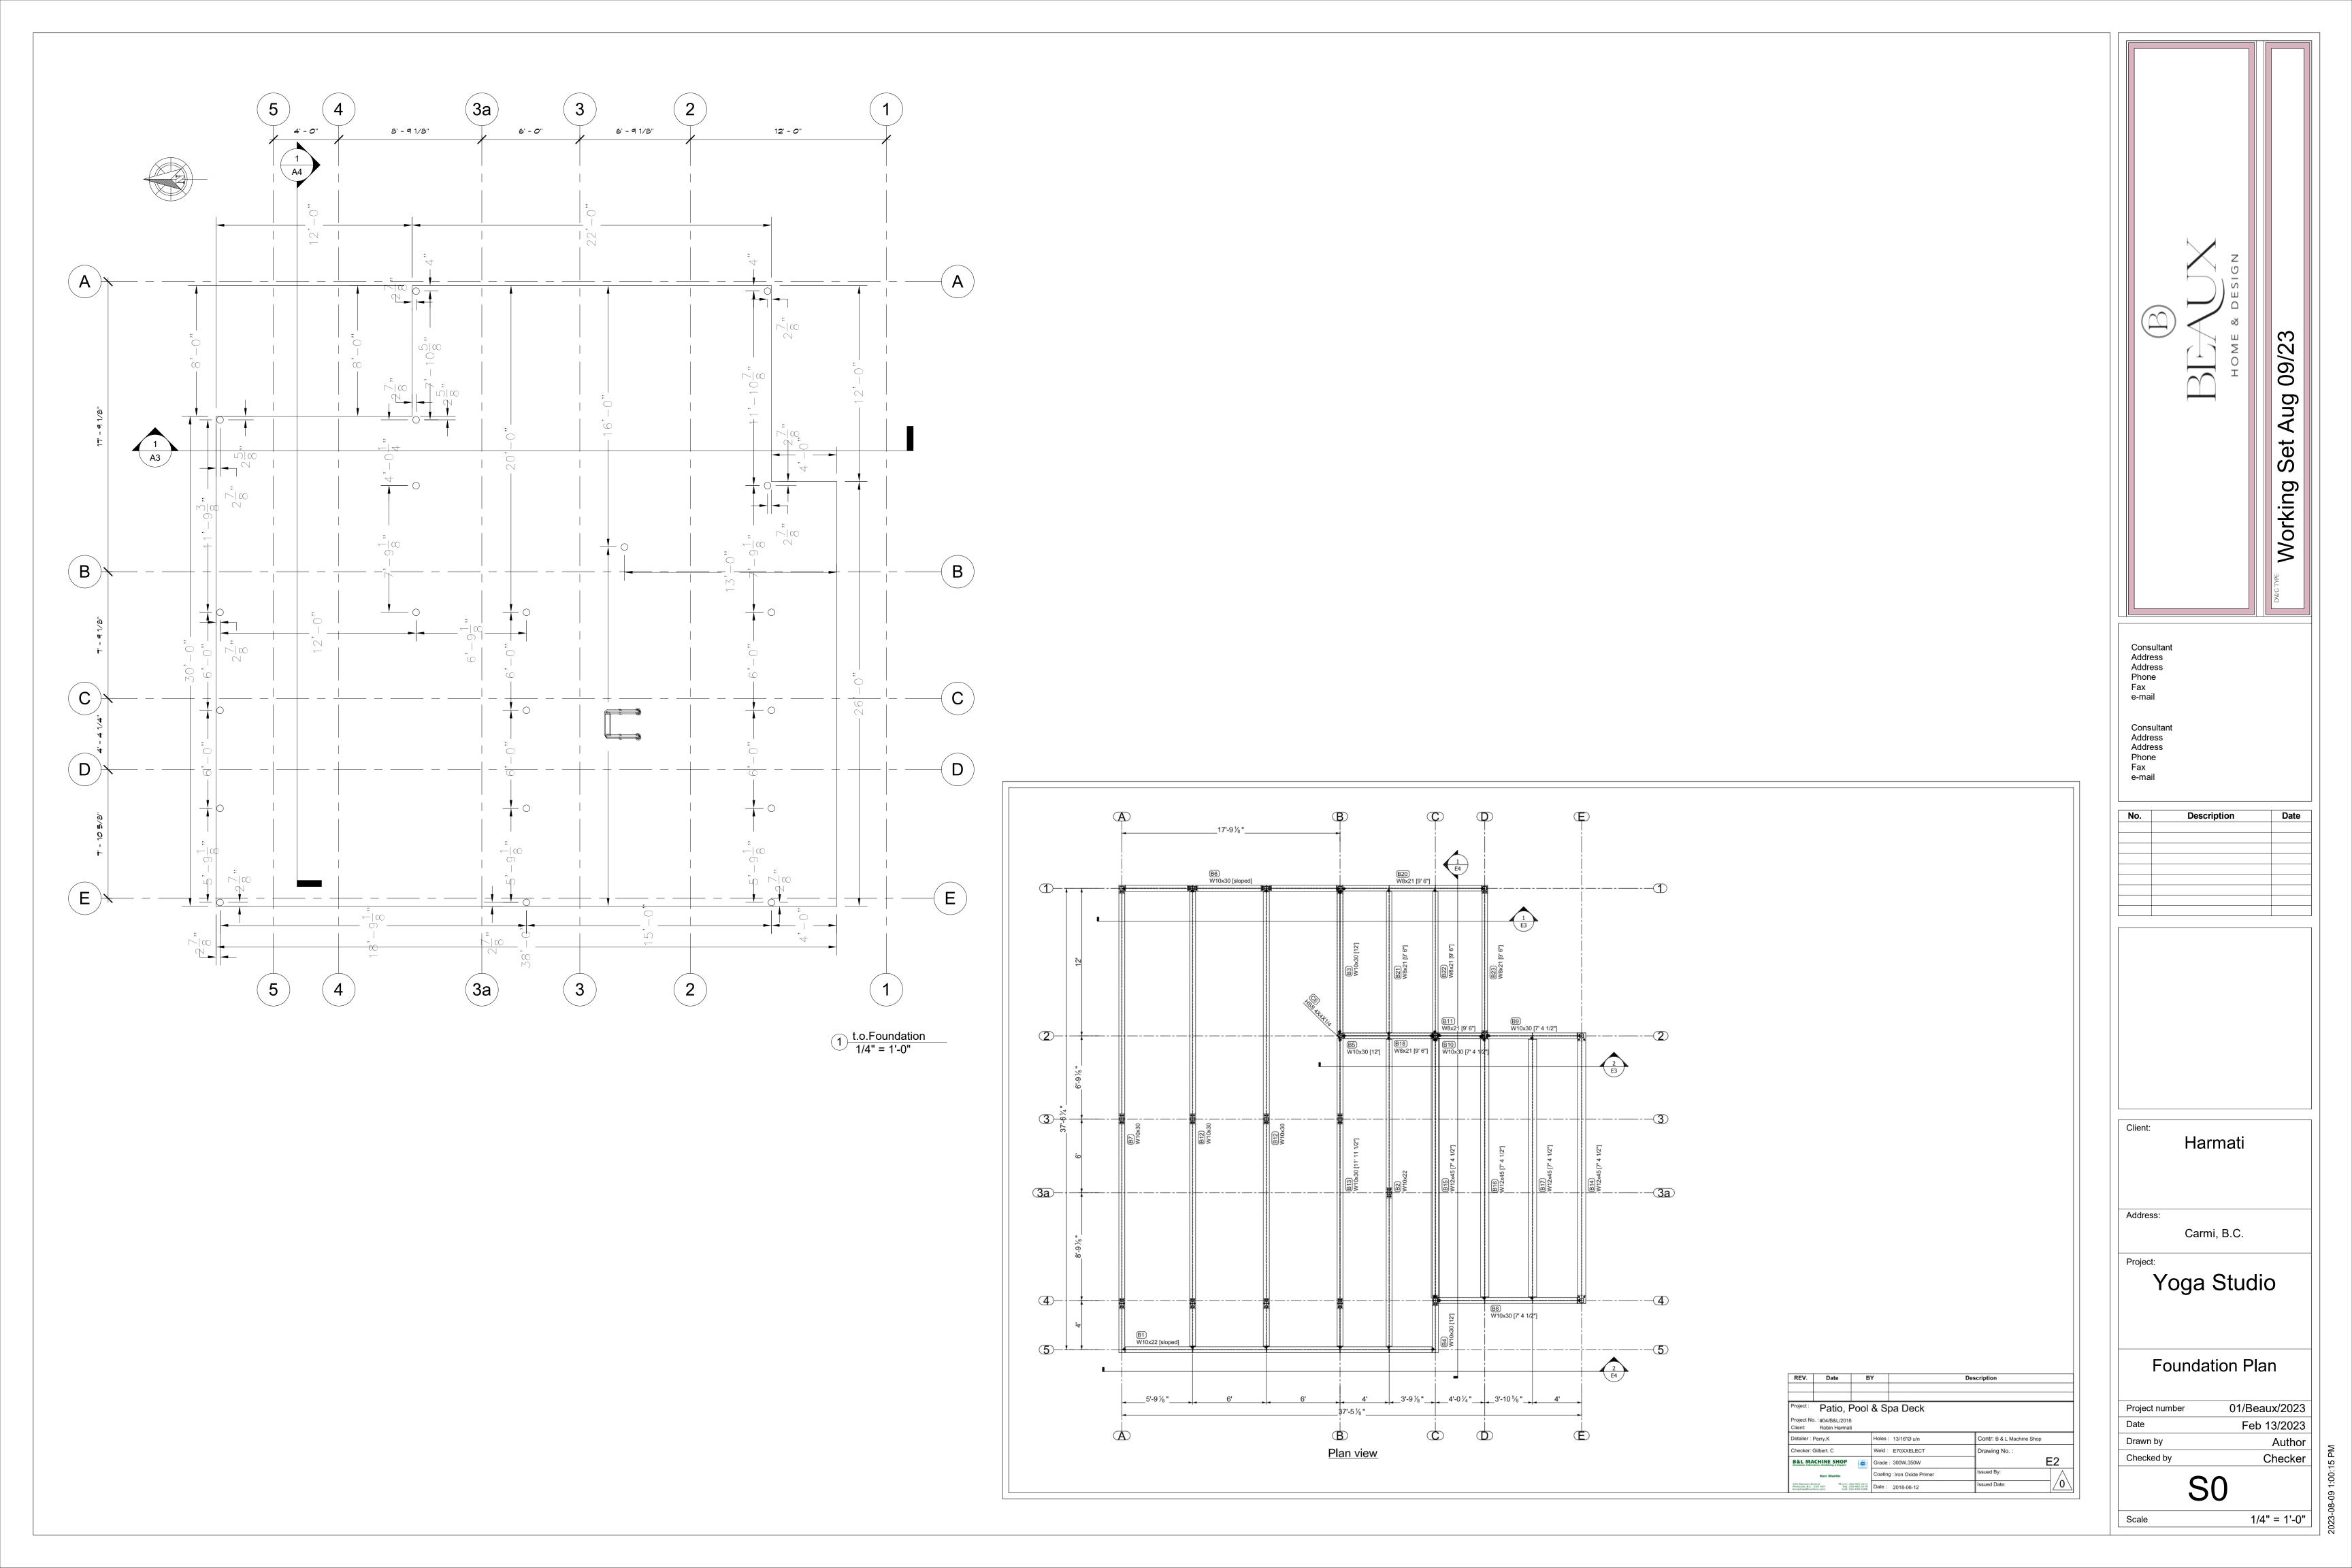

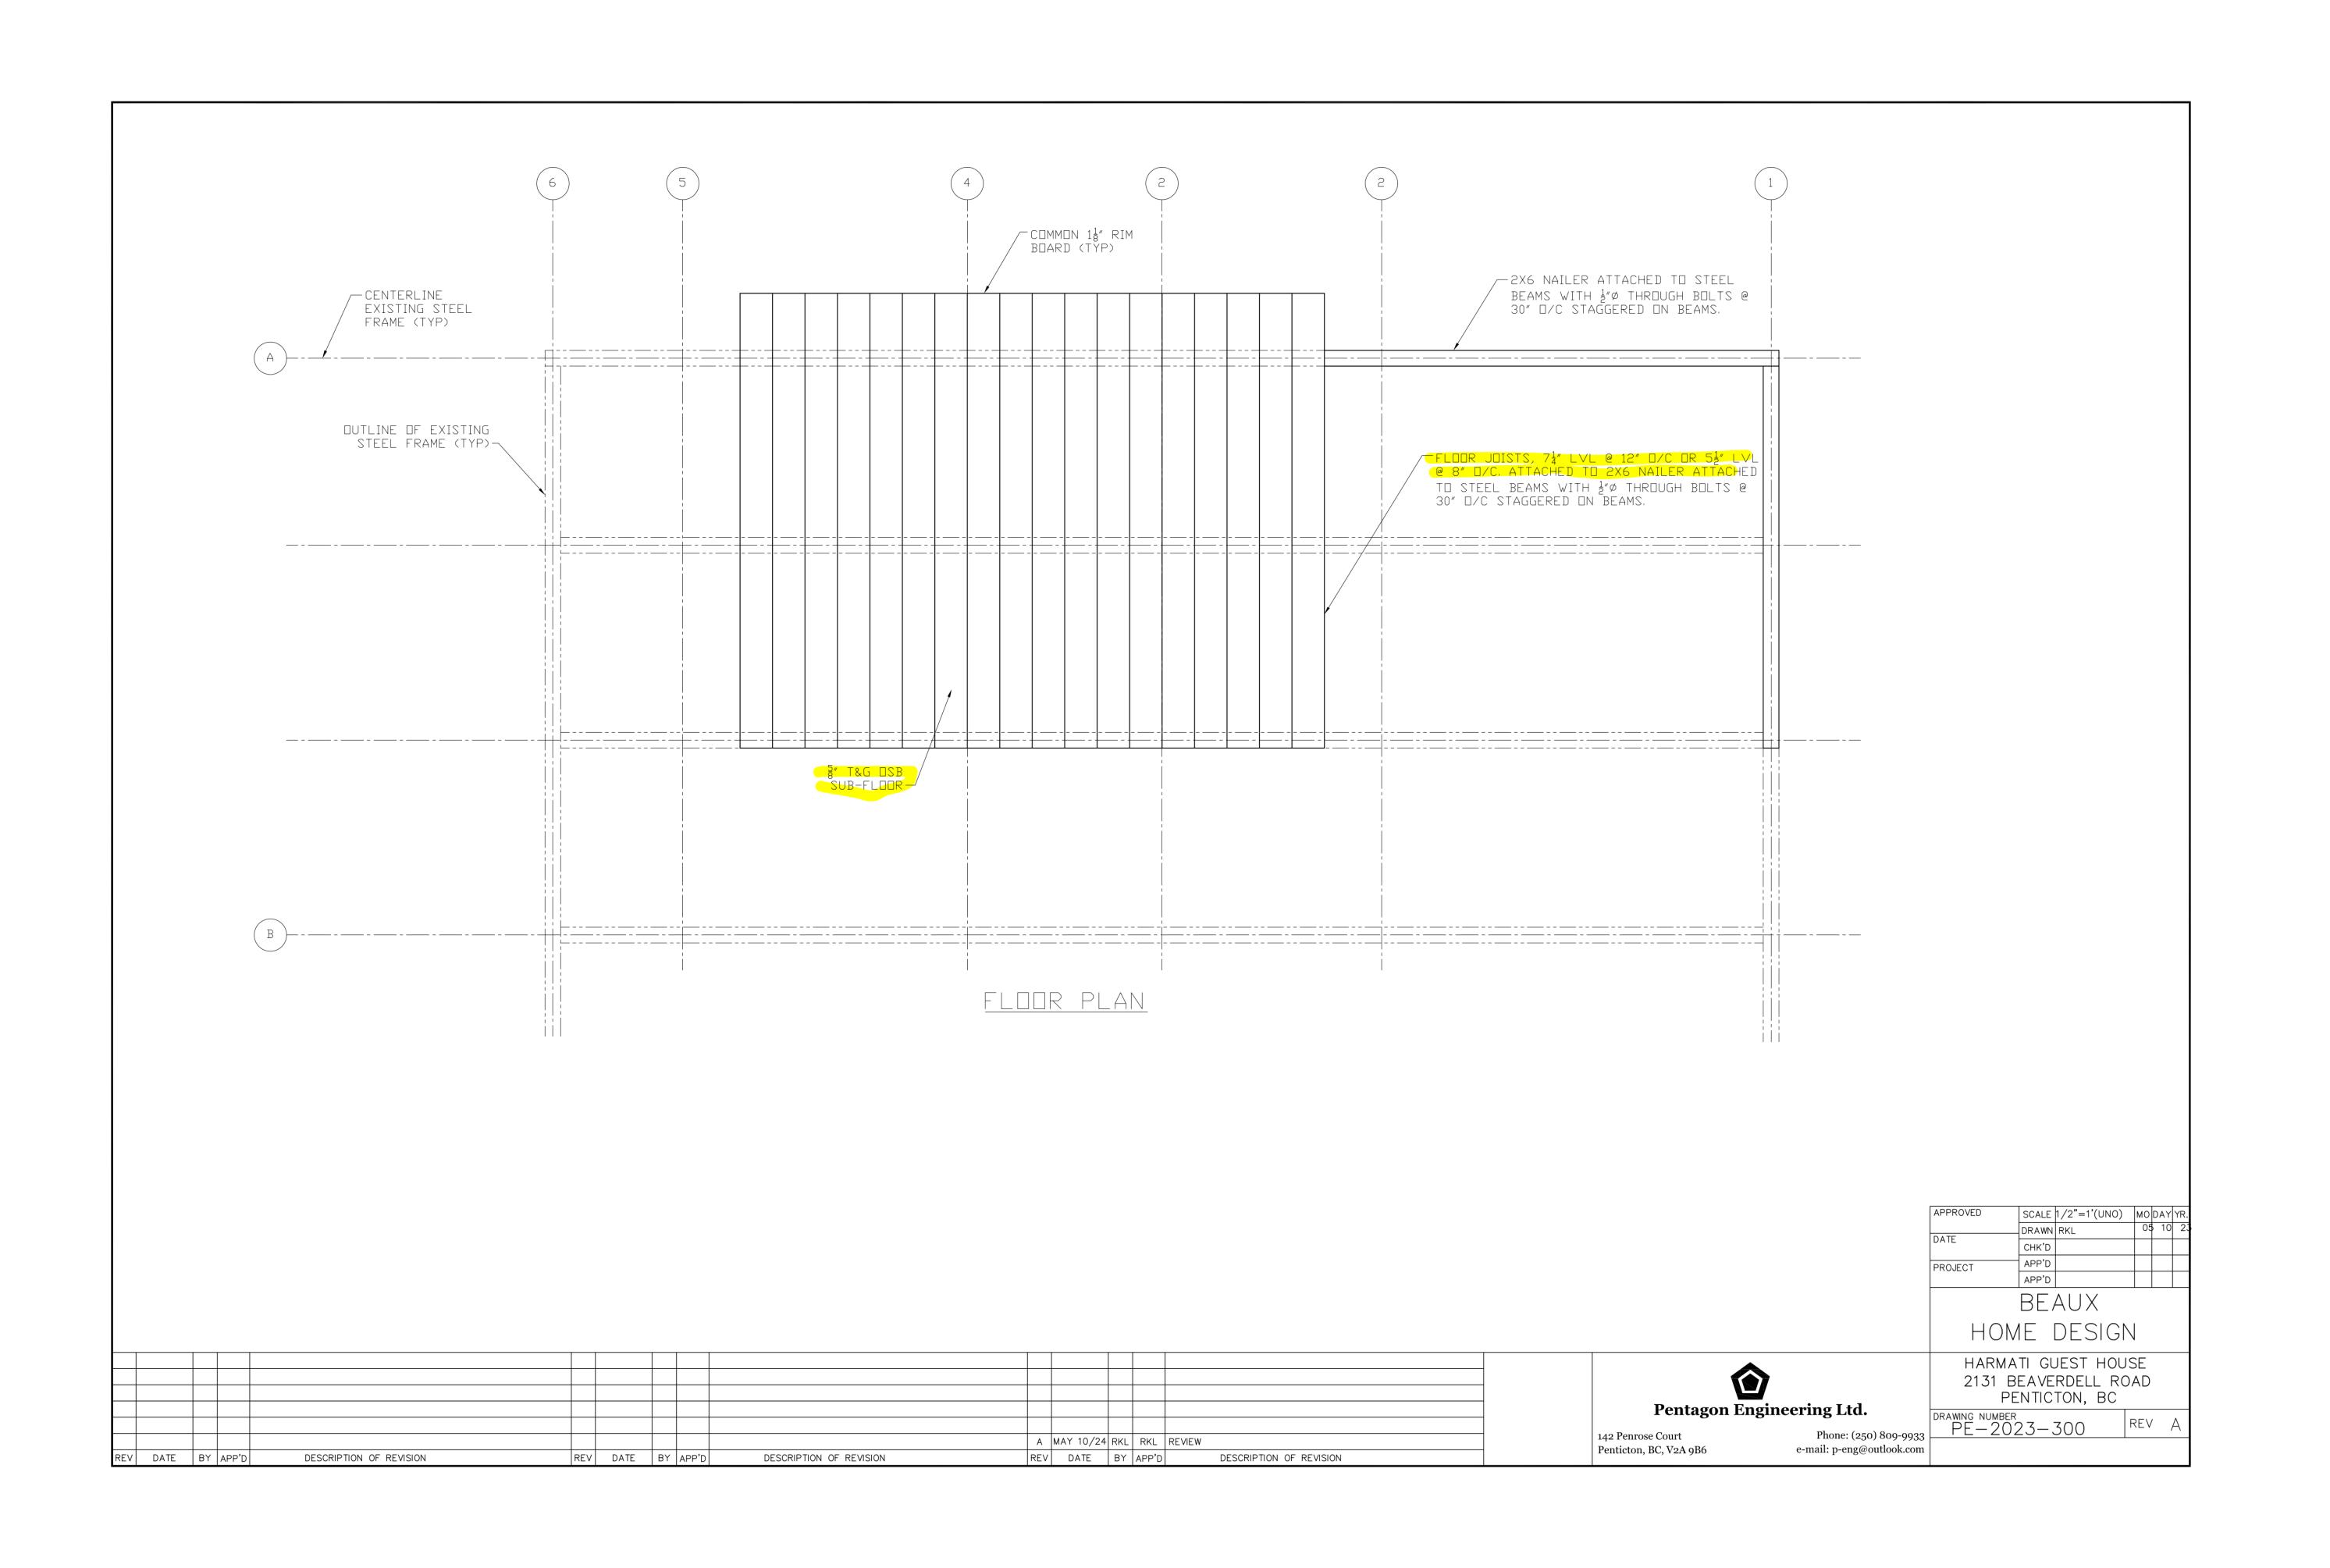

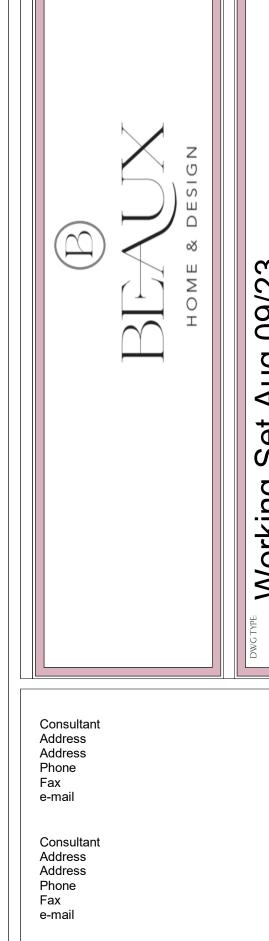

Client: Harmati

Address:

Carmi, B.C.

Project:

Yoga Studio

First Floor Framing Plan

Project number 01/Beaux/2023


Date Feb 13/2023


Drawn by Author

Checked by Checker

S1

Scale

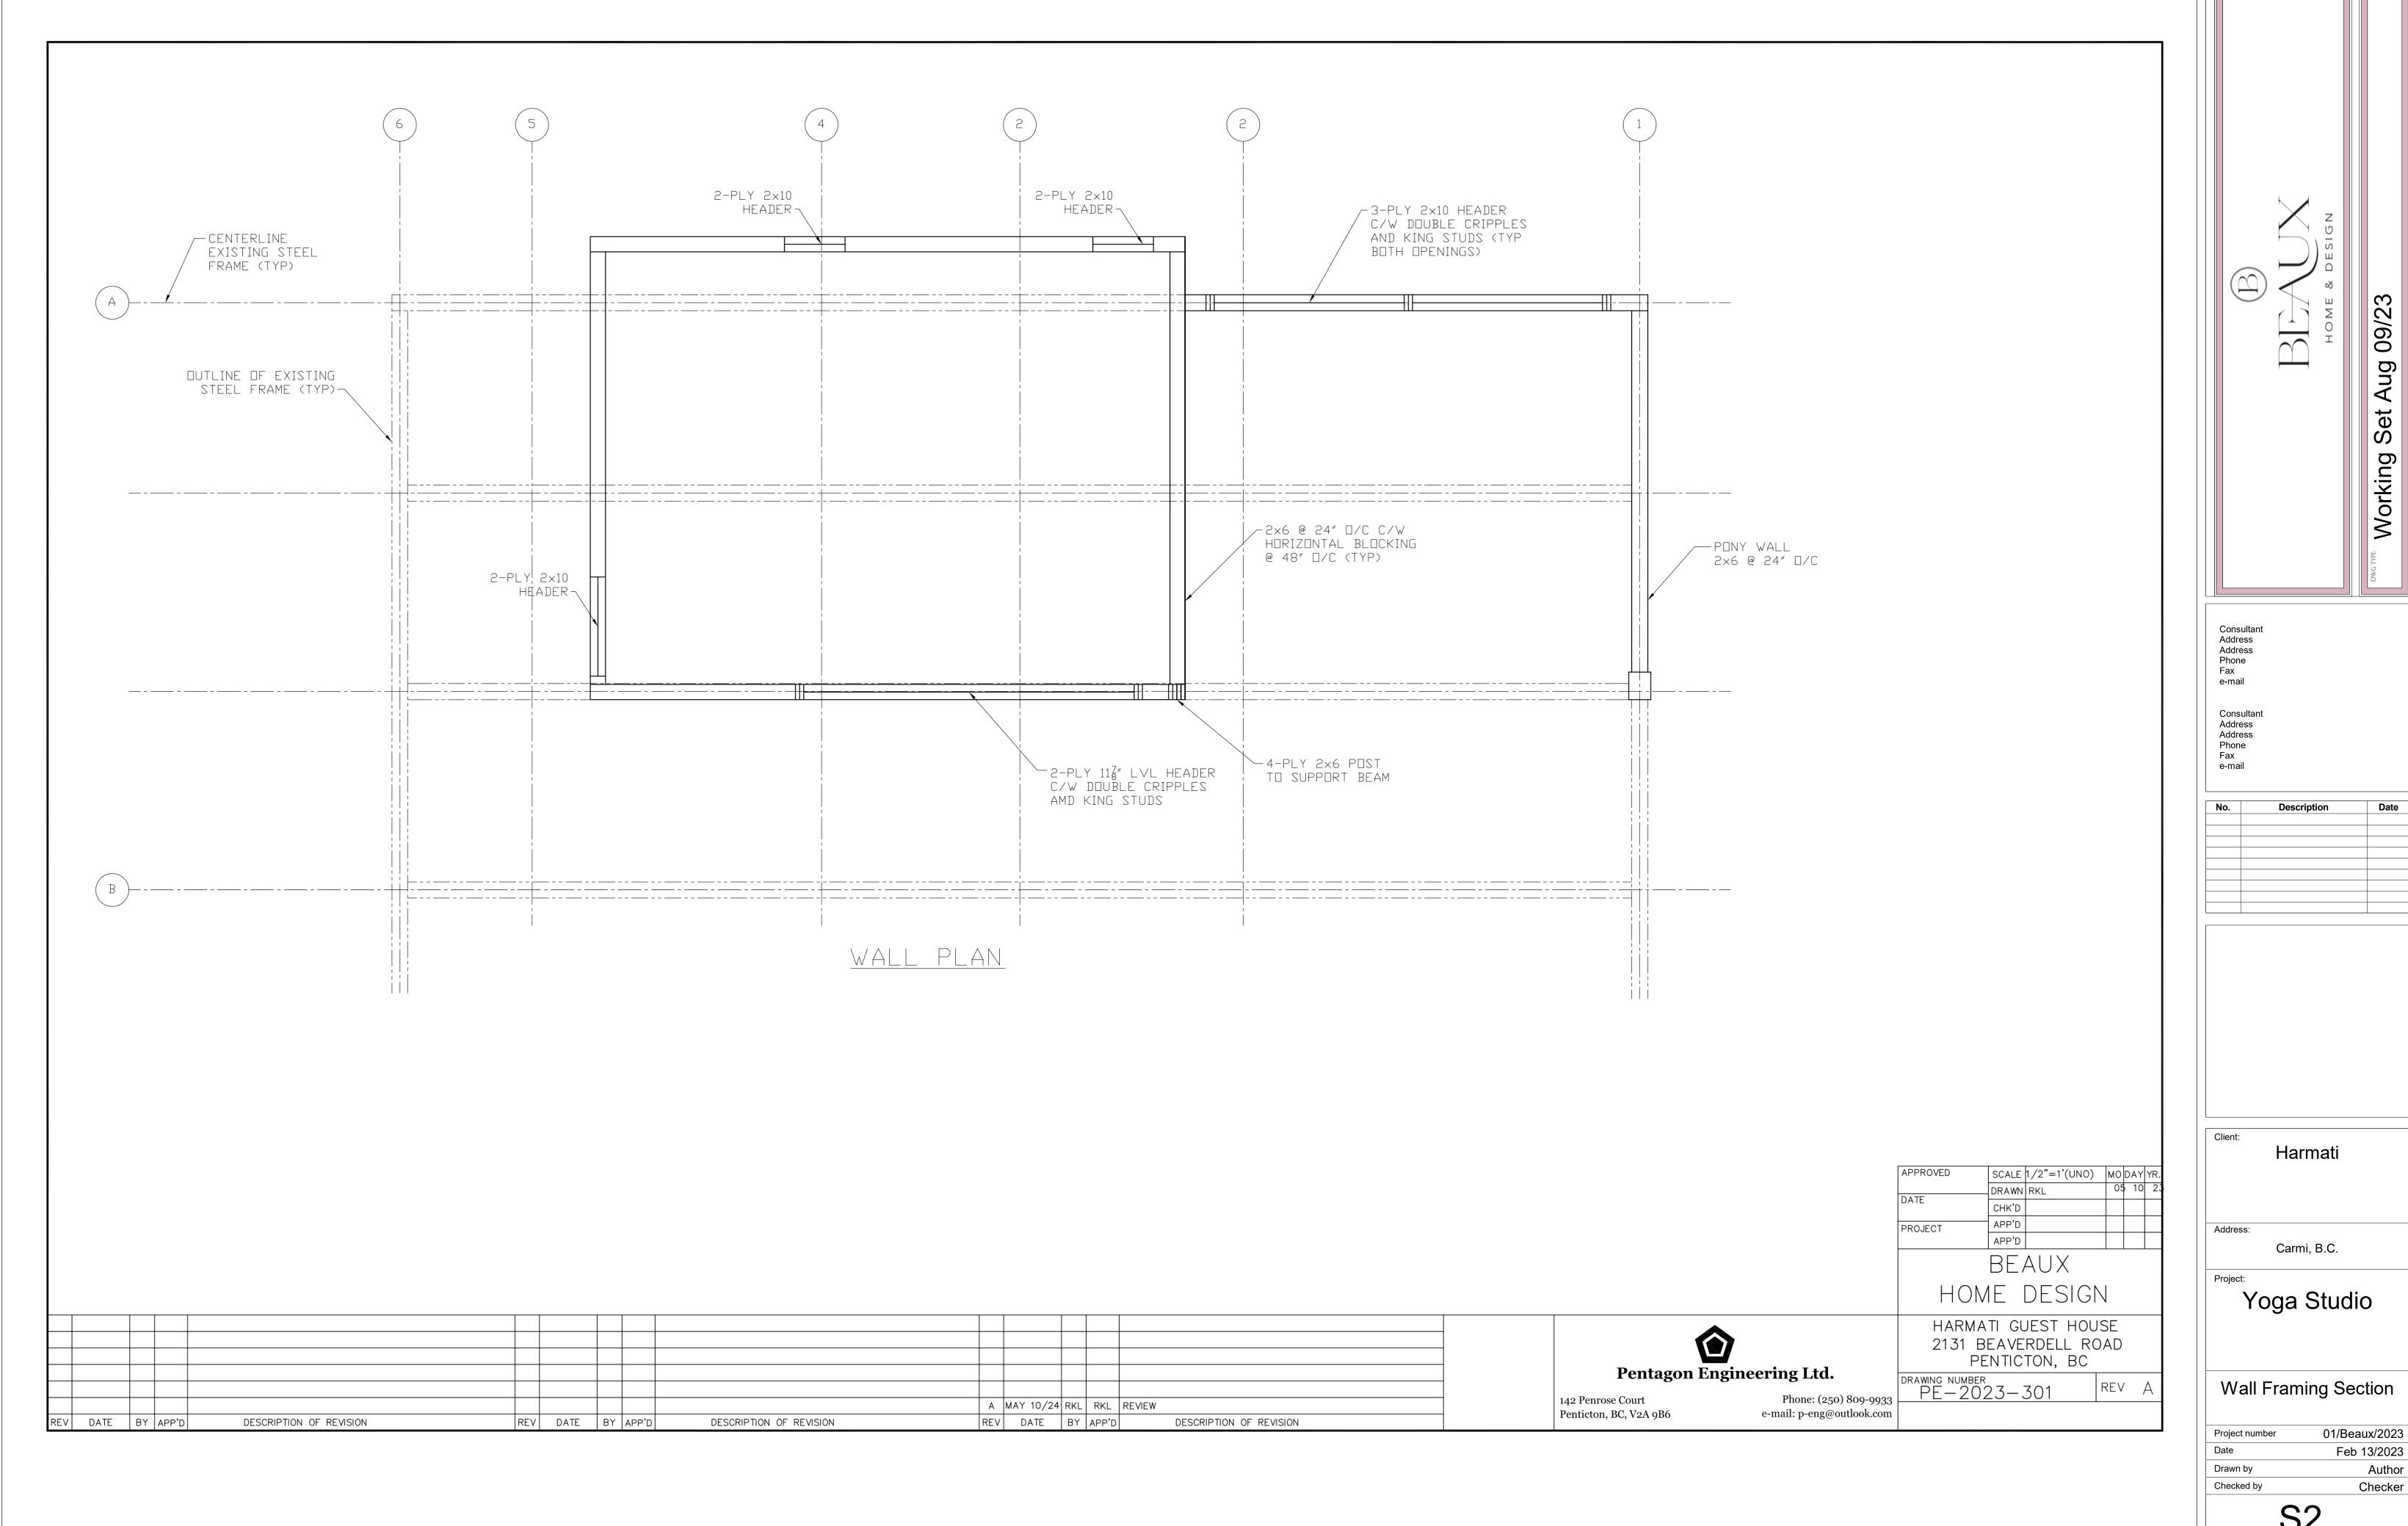

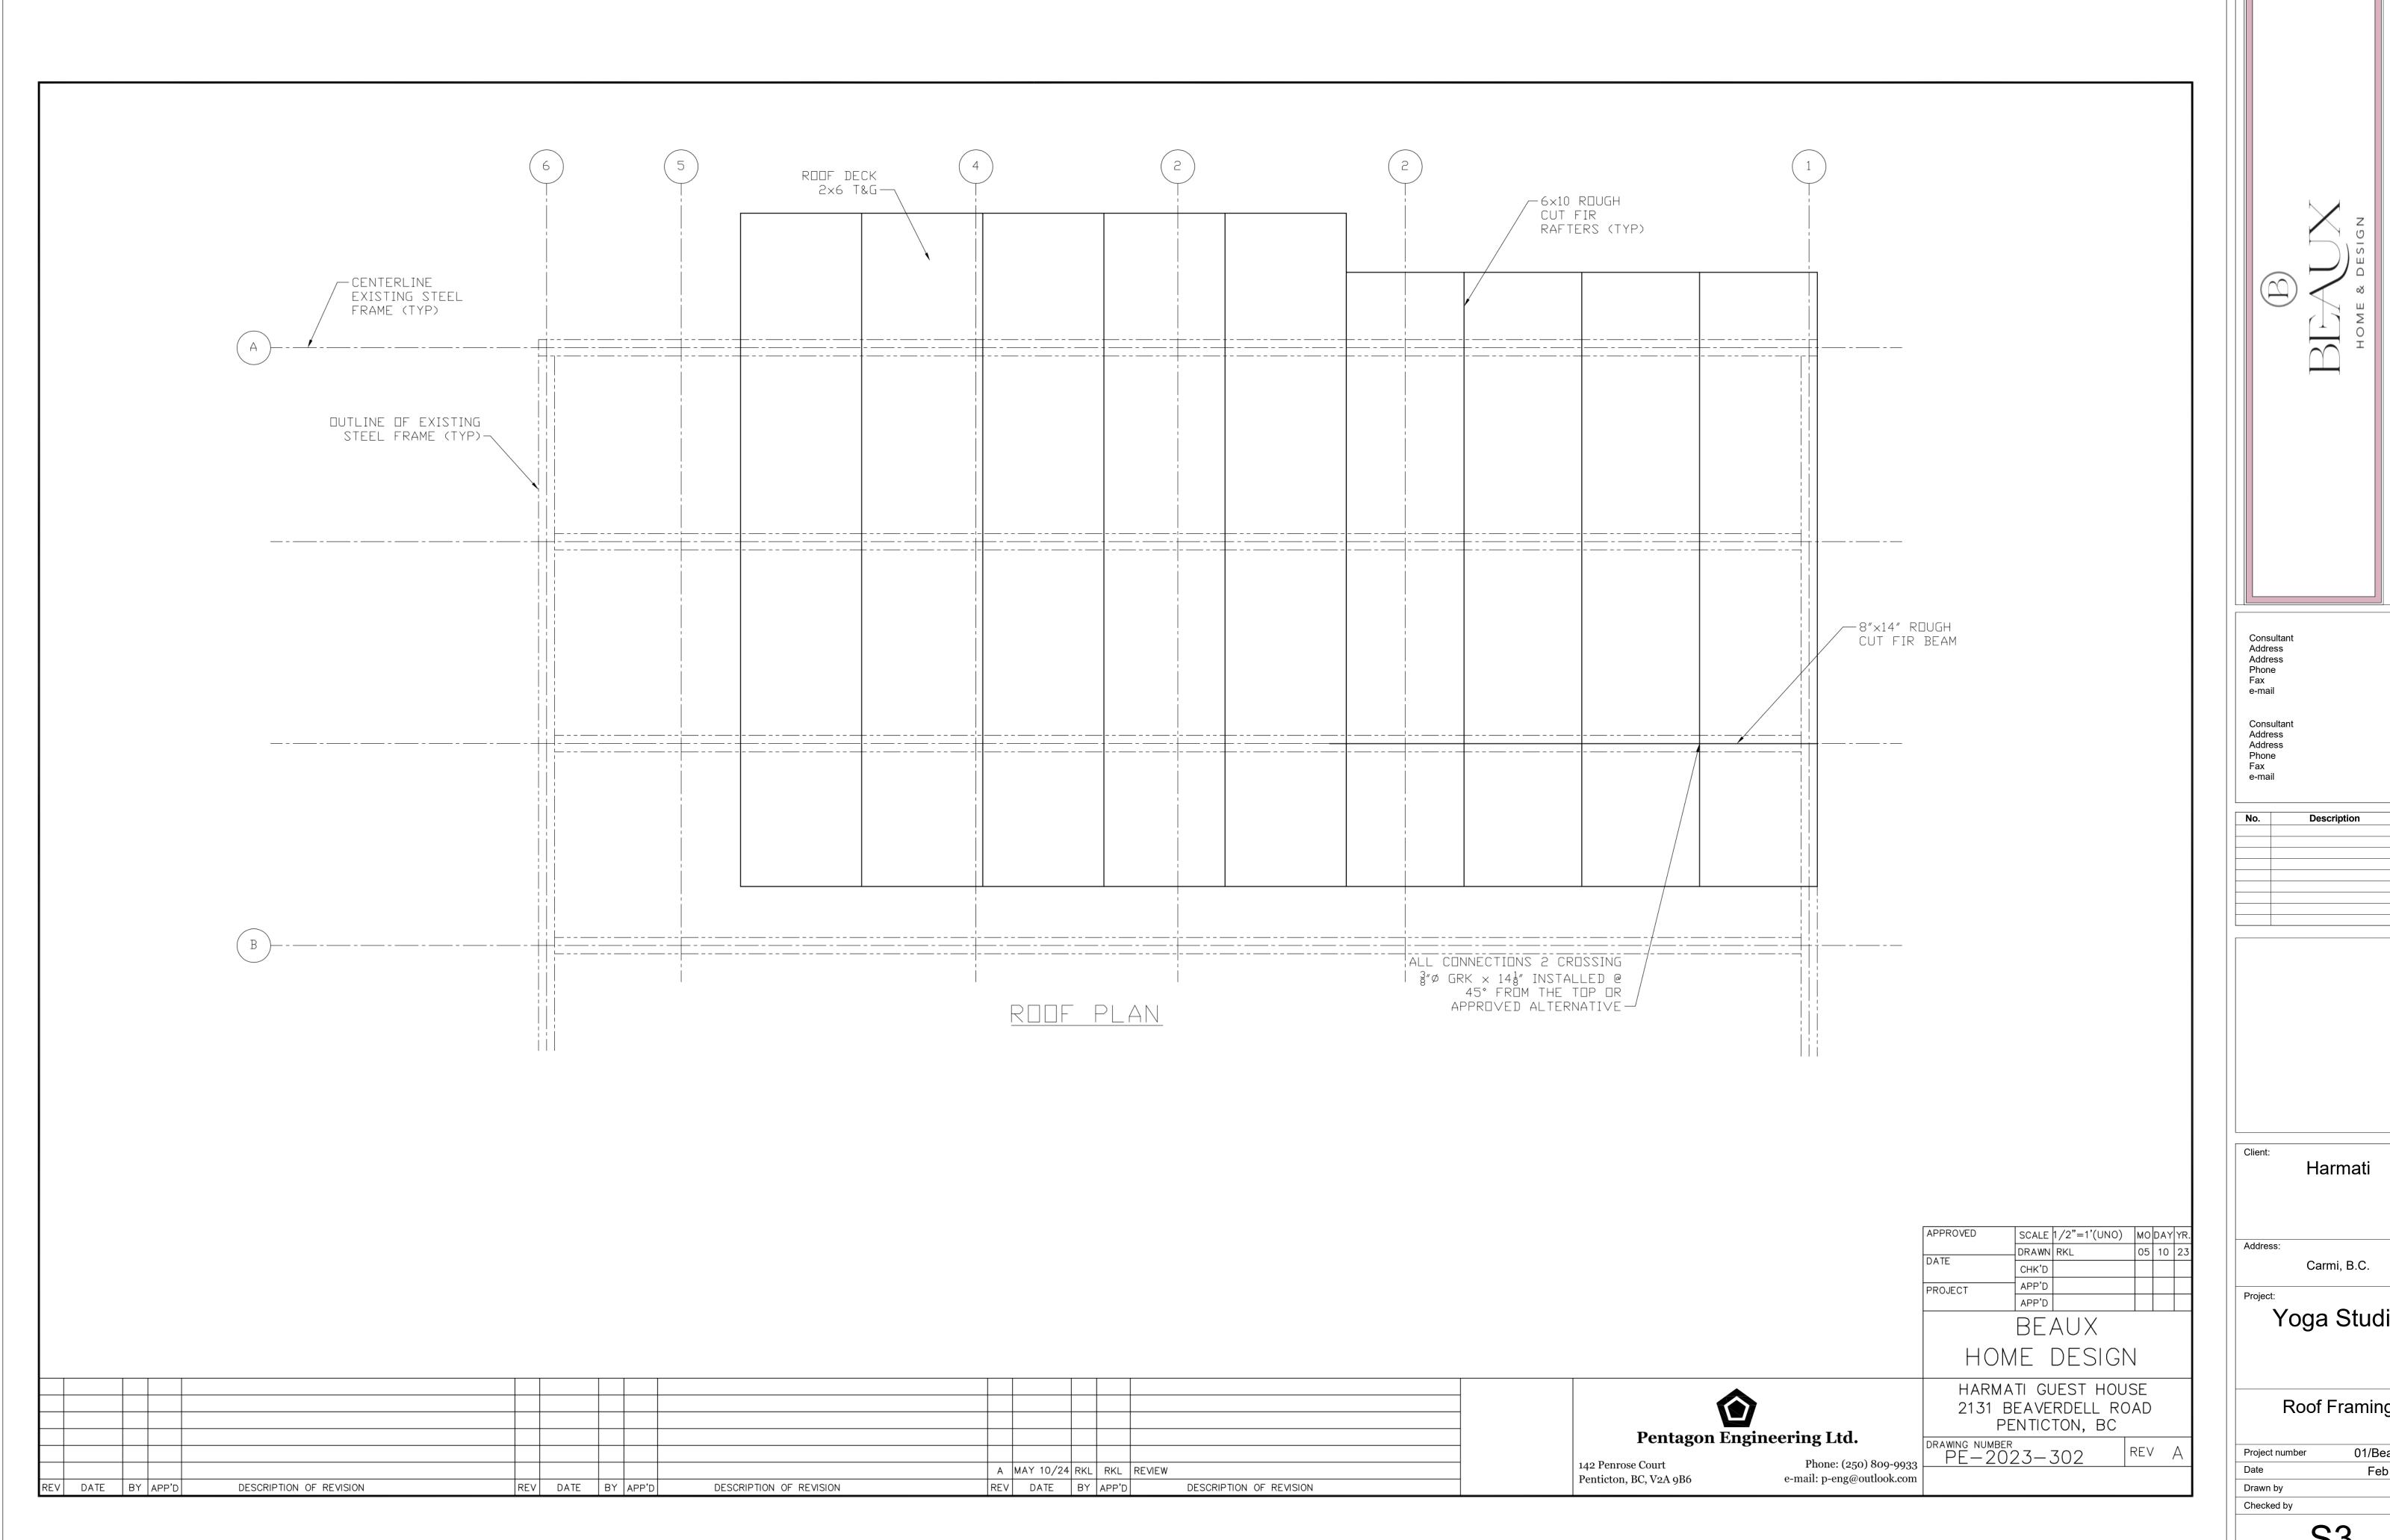

Yoga Studio

Roof Framing

01/Beaux/2023 Feb 13/2023 Author Checker

S3

Scale